

GENERAL PROJECT NOTES

- 1. REPORT ANY AND ALL DISCREPANCIES, ERROR OR OMISSIONS (INCLUDING) DIMENSIONS IN THE DOCUMENT TO THE ARCHITECT/DESIGNER PRIOR TO ORDERING ANY MATERIALS AND/OR THE COMMENCEMENT OF CONSTRUCTION.
 2. ALL DIMENSIONS SHALL BE VERRIFIED AT THE JOBSITE PRIOR TO START OF CONSTRUCTION.
 3. CONTRACTOR SHALL BE RESPONSIBLE FOR COORDINATING SUBCONTRACTOR SO THAT THEY ARE FAMILIAR WITH THE WORK AS SHOWN ON PLANS.
 4. ALL WORK SHALL COMPLY WITH ALL APPLICABLE CODES AND ORDINANCES, AS WELL AS TEXAS ACCESSIBILITY STANDARDS (TAS).
 5. ALL ARCHITECTURAL CONSTRUCTION TO BE COORDINATED WITH MECHANICAL, PLUMBING, ELECTRICAL, KITCHEN AND FIRE PROTECTION.
 6. AS THIS IS A TEMANT FRISH OUT, CONTRACTOR SHALL VERIFY LOCATION OF ALL EXISTING

- ELECTRICAL, KITCHEN AND FIRE PROTECTION.

 A ST HISI SA TEMANT FINISH OUT, CONTRACTOR SHALL VERIEF LOCATION OF ALL EXISTING UTILITIES, STRUCTURE AND TIE-INS. DRAWINGS ARE BASED ON INFORMATION PROVIDED BY THE SITE DEVELOPER AND ARE NOT TO BE ASSUMED AS AS-BUILT DRAWINGS.

 EXTERIOR DIMENSIONS ARE TO THE CENTERLINE OF COLUMNS, CENTERLINE OF OPENINGS AND FACE OF FOUNDATION, UNLESS OTHERWISE NOTED. INTERIOR DIMENSIONS ARE TO THE FACE OF FINISH WALL AND CENTER OF OPENINGS, TYPICAL, MAINTAIN DIMENSIONS MARKED "CLEAR", ALLOW FOR THICKINESS OF FINISHES.
- FOR THICKNESS OF FINISHES.

 8. UNDER NO CIRCUMSTANCE SHALL ANY DIMENSION BE SCALED FROM THESE DRAWINGS, ANY CRITICAL DIMENSION NOT GIVEN SHALL BE BROUGHT TO THE ATTENTION OF THE ARCHITECTIONSIGNER PRIOR TO CONSTRUCTION.

 9. ASSUME DOOR HEAD HEIGHT TO BE 7-07 ABOVE FINISH PLOOR UNLESS OTHERWISE NOTED.
- ALL PROTRUDING OBJECTS (E.G. WALL-MOUNTED TVS, FIRE EXTINGUISHERS, RESTROOM ACCESSORIES, ETC.) SHALL BE LOCATED TO COMPLY WITH TAS, AS REQUIRED.
- ACCESSORIES, ETC.) SHALL BE LOCATED TO COMPLY WITH YAS, AS REQUIRED.

 11. ADD INSULATION TO ALL EXPOSED PLUMBING PER TAS.

 12. ALL NEW ELEMENTS SHALL BE ACCOMMODATED AND INTEGRATED IF REQU'D INTO EXISTING STAUCTURE AND FINISHED SUFFACES SO AS TO PROVIDE A COMPLETE FINISHED ASSEMBLY, TYPICAL.

 13. CONTRACTOR TO PROVIDE CONDUIT FOR TELECOMMUNICATIONS, DATA, AND SECURITY SYSTEMS INSTALLATIONS AS REQ'D BY OWNER.

 14. CONTRACTOR TO PROVIDE EXISTS, EXIST LIGHTING, FIRE PROTECTIVE DEVICES AND ALARMS IN COMPLANCE WITH COLDES AND ORDINANCES.

 15. ALL WOOD BLOCKING AND WOOD SUBSTRATE TO BE FIRE RETARDANT TREATED WOOD.

- ALL STEEL TO BE FACTORY STEEL. ALL WELDS TO BE GROUND SMOOTH. ALL CORNERS TO BE MITER CUT, UNLESS OTHERWISE NOTED.

- 23, REFER TO FOOD SERVICE DRAWINGS FOR ALL KITCHEN EQUIPMENT INFORMATION.
- 24. PROVIDE BLOCKING/BACKING FOR ALL WALL MOUNTED ACCESSORIES, FURNISHINGS AND EQUIPMENT, CONTRACTOR TO VERIFY HEIGHTS AND LOCATIONS.
- 25. ALL INVALL BLOCKING LOCATIONS AT MITCHEN TO BE 16 GG QALVANIZED STEEL BACKING, BOTH SIDES OF WALL BLOCKING LOCATIONS AT MITCHEN TO BE 16 GG QALVANIZED STEEL BACKING, BOTH SIDES OF WALL WHERE APPLIES, CONTRACTOR TO VERIFY ALL CONDITIONS AND DIMENSIONS WITH OWNER AND KITCHEN CONSULTANT, REFER TO FOOD SERVICE DRAWINGS.



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\Box **a** 7866 **Burg**(Springtown Way e 100 \succeq Hopdoddy 200 Springtov Suite 100 San Marcos,

AUBREYCARTERDESIGN 906 E. 5th STREET SUITE 210 AUSTIN, TX 78702 512-656-3145




DATE: 9/26/2018 SSUE: Permit Review DRAWN BY: KSJ CHECKED BY: AC

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SHEET NO. 4 OF 10



ARCHITECTURAL SITE PLAN SCALE: 1" = 10'-0"

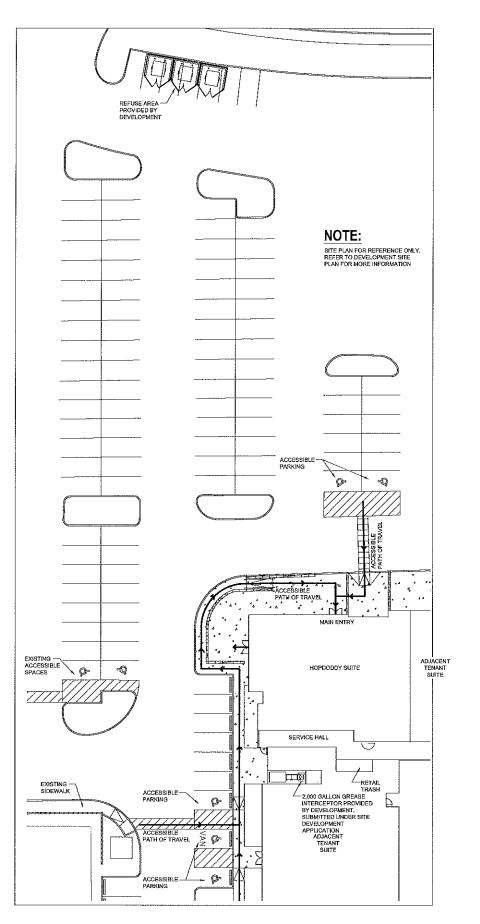

GENERAL PROJECT NOTES

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 4. ALL WORK SHALL COMPLY WITH ALL APPLICABLE CODES AND ORDINANCES, AS WELL AS TEXAS ACCESSIBILITY STANDARDS (TAS).

 5. ALL ARCHITECTURAL CONSTRUCTION TO BE COORDINATED WITH MECHANICAL, PLUMBING, ELECTRICAL, KITCHEN AND FIRE PROTECTION.

 6. AS THIS IS A TEMANT FINISH OUT, CONTRACTOR SHALL VERIFY LOCATION OF ALL EXISTING UTILITIES, STRUCTURE AND THE HIS DRAWINGS ARE BASED ON INFORMATION PROVIDED BY THE SITE DEVELOPER AND ARE NOT TO BE ASSUMED AS S-BUILT DRAWINGS.

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 9. ASSUME DOOR HEAD HEIGHT TO BE "70" ABOVE FINISH FLOOR UNLESS OTHERWISE NOTED.

 10. ALL PROTRIDING OBJECTS (E.G. WALL-MOUNTED TVS, FIRE EXTINGUISHERS, RESTROOM ACCESSORIES, ETC.) SHALL BE LOCATED TO COMPLY WITH TAS, AS REQUIRED.

- 11. ADD INSULATION TO ALL EXPOSED PLUMBING PER TAS.
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 13. CONTRACTOR TO PROVIDE CONDUIT FOR TELECOMMUNICATIONS, DATA, AND SECURITY SYSTEMS INSTALLATIONS AS RECID BY OWNER.
 14. CONTRACTOR TO PROVIDE EXISTS, EXIST LIGHTING, FIRE PROTECTIVE DEVICES AND ALARMS IN COMPLIANCE WITH CODES AND ORDINANCES.
 15. ALL WOOD BLOCKING AND WOOD SUBSTRATE TO BE FIRE RETARDANT TREATED WOOD.
 16. ALL STEEL TO BE FACTORY STEEL, ALL WILDED TO BE GROUND SMOOTH, ALL CORNERS TO BE MITTER CULT, UNILESS OTHERWISE NOTED.
 17. INTERIOR PARTITIONS TO BE METAL STUD CONSTRUCTION UNLESS OTHERWISE NOTED. REFER TO FINISH SCHEDULE FOR FINISH TREATMENT.
 18. REFER TO FOOD SERVICE DRAWINGS FOR BAR AND KITCHEN EQUIPMENT INFORMATION.
 19. REFER TO MECHANICAL, PLUMBING AND ELECTRICAL DRAWINGS FOR COORDINATION INFORMATION OF KITCHEN EQUIPMENT.

- 20. FIRE SPRINKLER AND ALARM SYSTEMS WILL BE DESIGNED BY SYSTEMS INSTALLERS AND THEIR FIRE PROTECTION ENGINEERS. REFER TO LIST OF DEFERRED SUBMITTALS.



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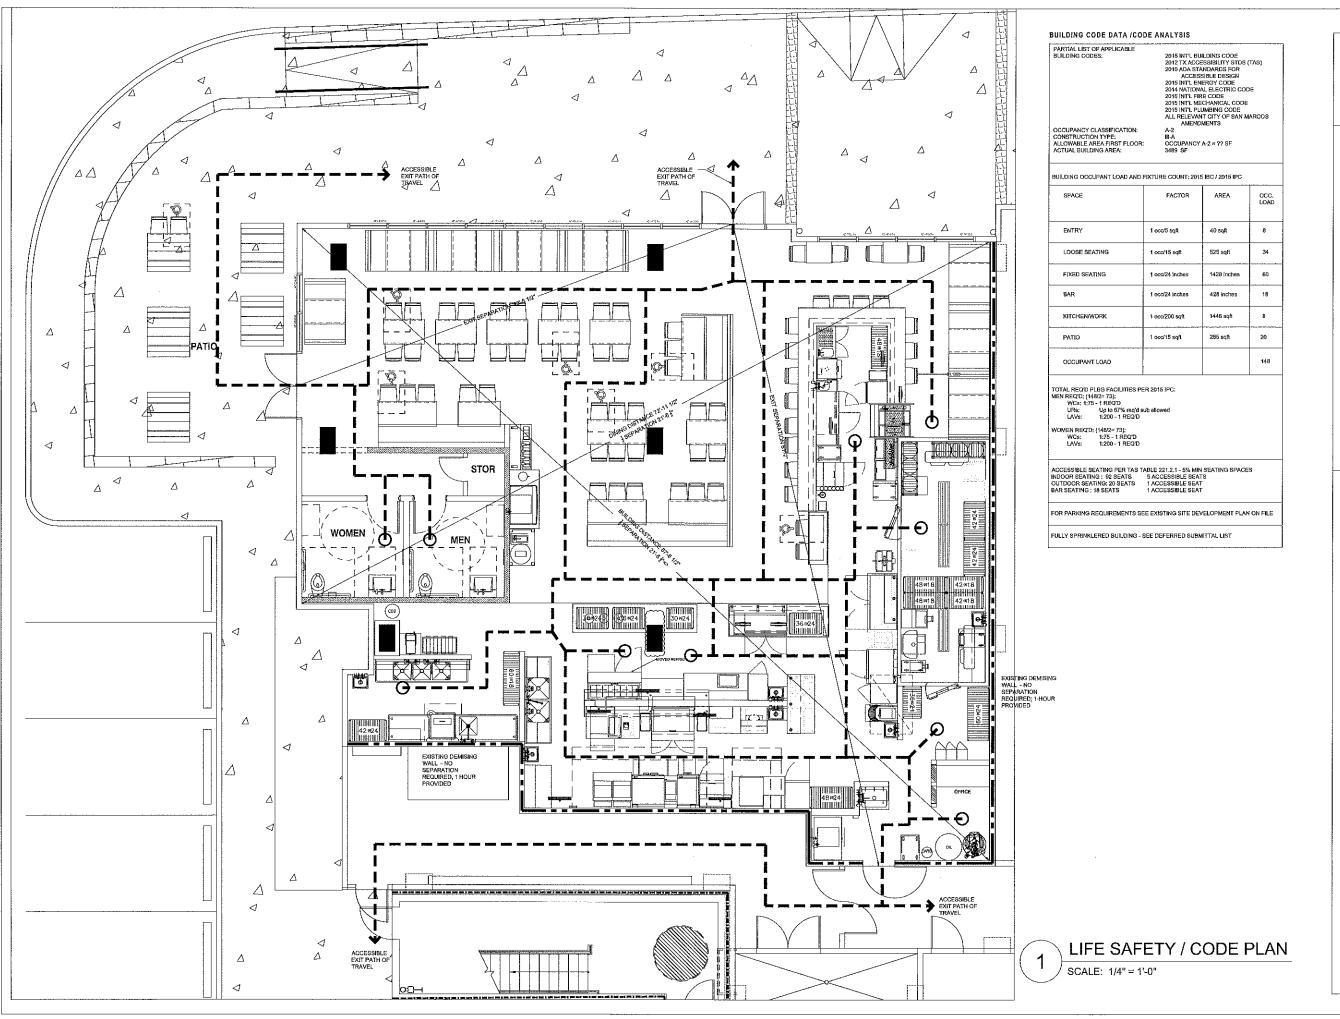
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SHEET NO. 2 OF 10



PROJECT



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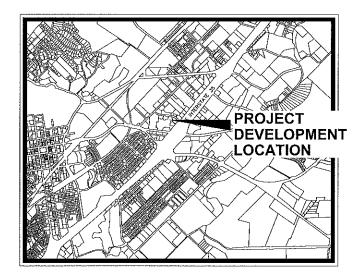
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HOPDODDY BURGER BAR




Springtown Center 200 Springtown Way, Suite 100 San Marcos, Tx 78666

VICINITY MAP



SITE MAP

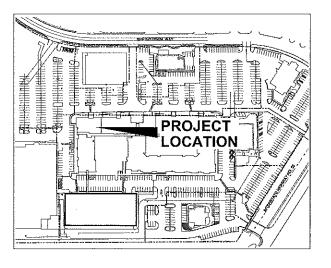

PROJECT DATA

PROJECT DESCRIPTION

DESIGNER

MECHANICAL ENGINEER

KITCHEN CONSULTANT

NEW RESTAURANT INTERIOR FINISH OUT IN NEW VERTICAL MIXED USE DEVELOPMENT PROJECT ADDRESS 200 SPRINGTOWN WAY, SLITE 100 HOPDODDY BURGER BAR APPLICANT LOT ZONING BUILDING OCCUPANCY TENANT SPACE OCCUPANCY A-2: ASSEMBLY TYPE OF CONSTRUCTION PROJECT AREA INTERIOR FINISH OUT

CONTACT INFORMATION

AUBREY CARTER DESIGN 906 E, 5TH STREET, SUITE 210

COMMERCIAL DESIGN &

GOMMERCIAL CONTRACTING 1602 W. ENCANTO BLVD PHOENIX, AZ 85007 T: 602.252.8032 JUDE JENNERS

APPLICABLE CODES

THE FOLLOWING CODES ADOPTED BY THE CITY OF SAN MARCOS, TEXAS

INTERNATIONAL BUILDING CODE 2015 EDITION, INCLUDING APPENDICES C. E. F. I. INTERNATIONAL PROPERTY MAINTENANCE CODE 2015 EDITION, INCLUDING APPENDIX A INTERNATIONAL MECHANICA CODE 2015 EDITION, INTERNATIONAL PLUMBING CODE 2015 EDITION, INTERNATIONAL FUEL GAS CODE 2015 EDITION, INTERNATIONAL RESIDENTIAL CODE FOR ONE- AND TWO-FAMILY DWELLINGS 2015 EDITION. NATIONAL ELECTRICAL CODE 2014 EDITION. INTIDANCE CERTIFICA CORP. 2016 AND BOTTON.

INTERNATIONAL ENERGY CONSERVATION CODE 2009 EDITION.

INTERNATIONAL FIRE CODE 2015 EDITION, INCLUDING APPENDICES 8, D, E, F, G, I AND J.

INTERNATIONAL SWIMMING POOL AND SPA CODE 2015 EDITION.

INTERNATIONAL EXISTING BUILDING CODE 2015 CHAPTER 4. LOCAL AMENDMENTS TO THESE ADOPTED CODES

DEFERRED SUBMITTALS

THE FIRE SPRINKLER SYSTEM DESIGN AND CONSTRUCTION DOCUMENTS WILL BE SUBMITTED SEPARATELY BY THE SYSTEM INSTALLER AND HIS FIRE PROTECTION ENGINEER.

ANY SIGNAGE DESIGN PERMIT DOCUMENTS WILL BE SUBMITTED SEPARATELY BY THE SIGNAGE DESIGNER.

HOOD SUPPRESSION SYSTEM DESIGN PERMIT DOCUMENTS WILL BE SUBMITTED SEPARATELY BY THE SYSTEMS INSTALLER AND HIS FIRE PROTECTION ENGINEER.

SCHEDULE OF DRAWINGS

ARCHITECTURAL

TITLE SHEET

TITLE SHEET

ARCHITECTURAL SITE PLAN
EGRESSCODE COMPLIANCE PLAN
FLOOR PLAN
DIMENSIONAL FLOOR PLAN
EFLECTE CELLING PLAN
EXTERIOR ELEVATIONS
INTERIOR ELEVATIONS
INTERIOR ELEVATIONS
BESTROOM ELEVATIONS
BESTROOM ELEVATIONS

STRUCTURAL FOUNDATION PLAN MEZZANINE FRAMING / DETAILS

MECHANICAL

ROOF PLAN / SCHEDULES COM CHECK

PLUMBING

ELECTRICAL

ELECTRICAL POWER PLAN
PANEL SCHEDULE / RISER DIAGRAM/ LOAD ANALYSIS
ROOF PLAN / LIGHTING COMPLIANCE

FOOD SERVICE

EQUIPMENT PLAN EQUIPMENT SCHEDULE GENERAL NOTES
PLUMBING PLAN
ELECTRICAL PLAN
SPECIAL CONDITIONS
BEVERAGE LINE & WALL BACKING
ELEVATIONS
ELEVATIONS
ELEVATIONS

KITCHEN EXHAUST

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